



three eighths inch = one foot  
one eighth inch = one foot  
one quarter inch = one foot  
one half inch = one foot  
three quarters inch = one foot  
one inch = one foot  
one and one half inches = one foot  
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four inches = one foot  
five inches = one foot  
six inches = one foot  
seven inches = one foot  
eight inches = one foot  
nine inches = one foot  
ten inches = one foot  
eleven inches = one foot  
twelve inches = one foot  
thirteen inches = one foot  
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eighty five inches = one foot  
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eighty seven inches = one foot  
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eighty nine inches = one foot  
ninety inches = one foot  
ninety one inches = one foot  
ninety two inches = one foot  
ninety three inches = one foot  
ninety four inches = one foot  
ninety five inches = one foot  
ninety six inches = one foot  
ninety seven inches = one foot  
ninety eight inches = one foot  
ninety nine inches = one foot  
one hundred inches = one foot

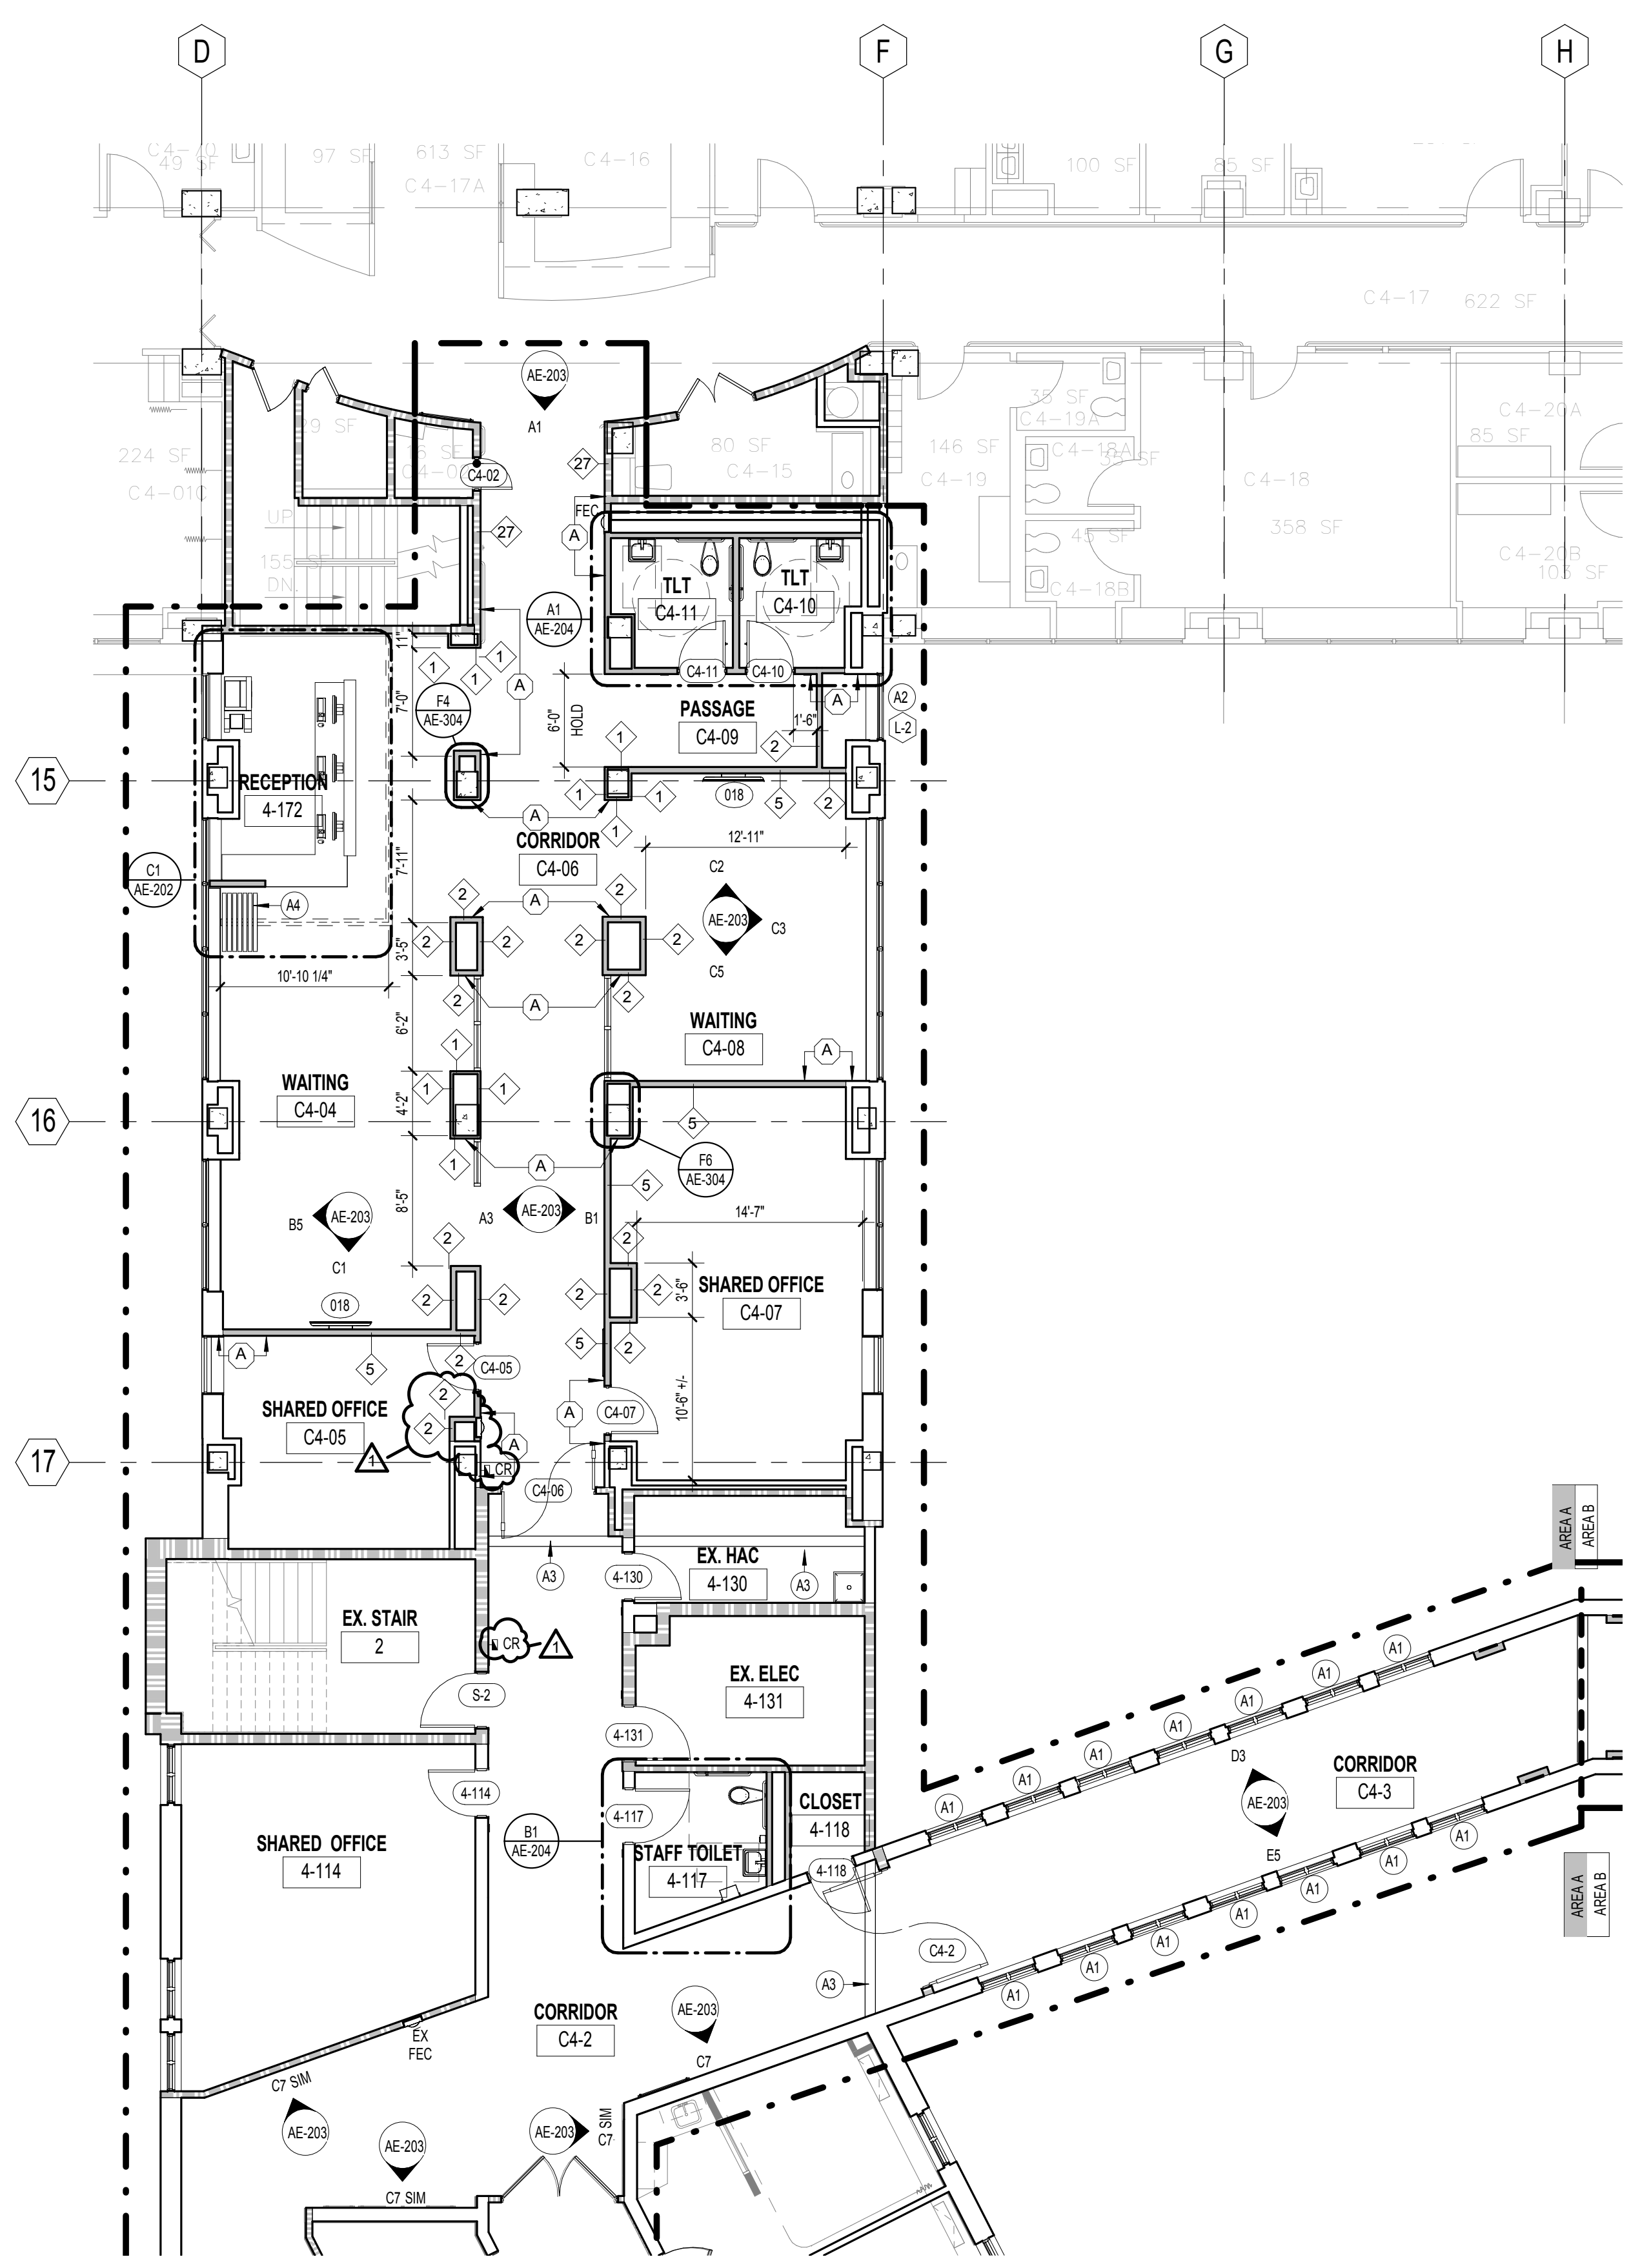

F1 FOURTH FLOOR ARCHITECTURAL PLAN AREA A  
1/8" = 1'-0"

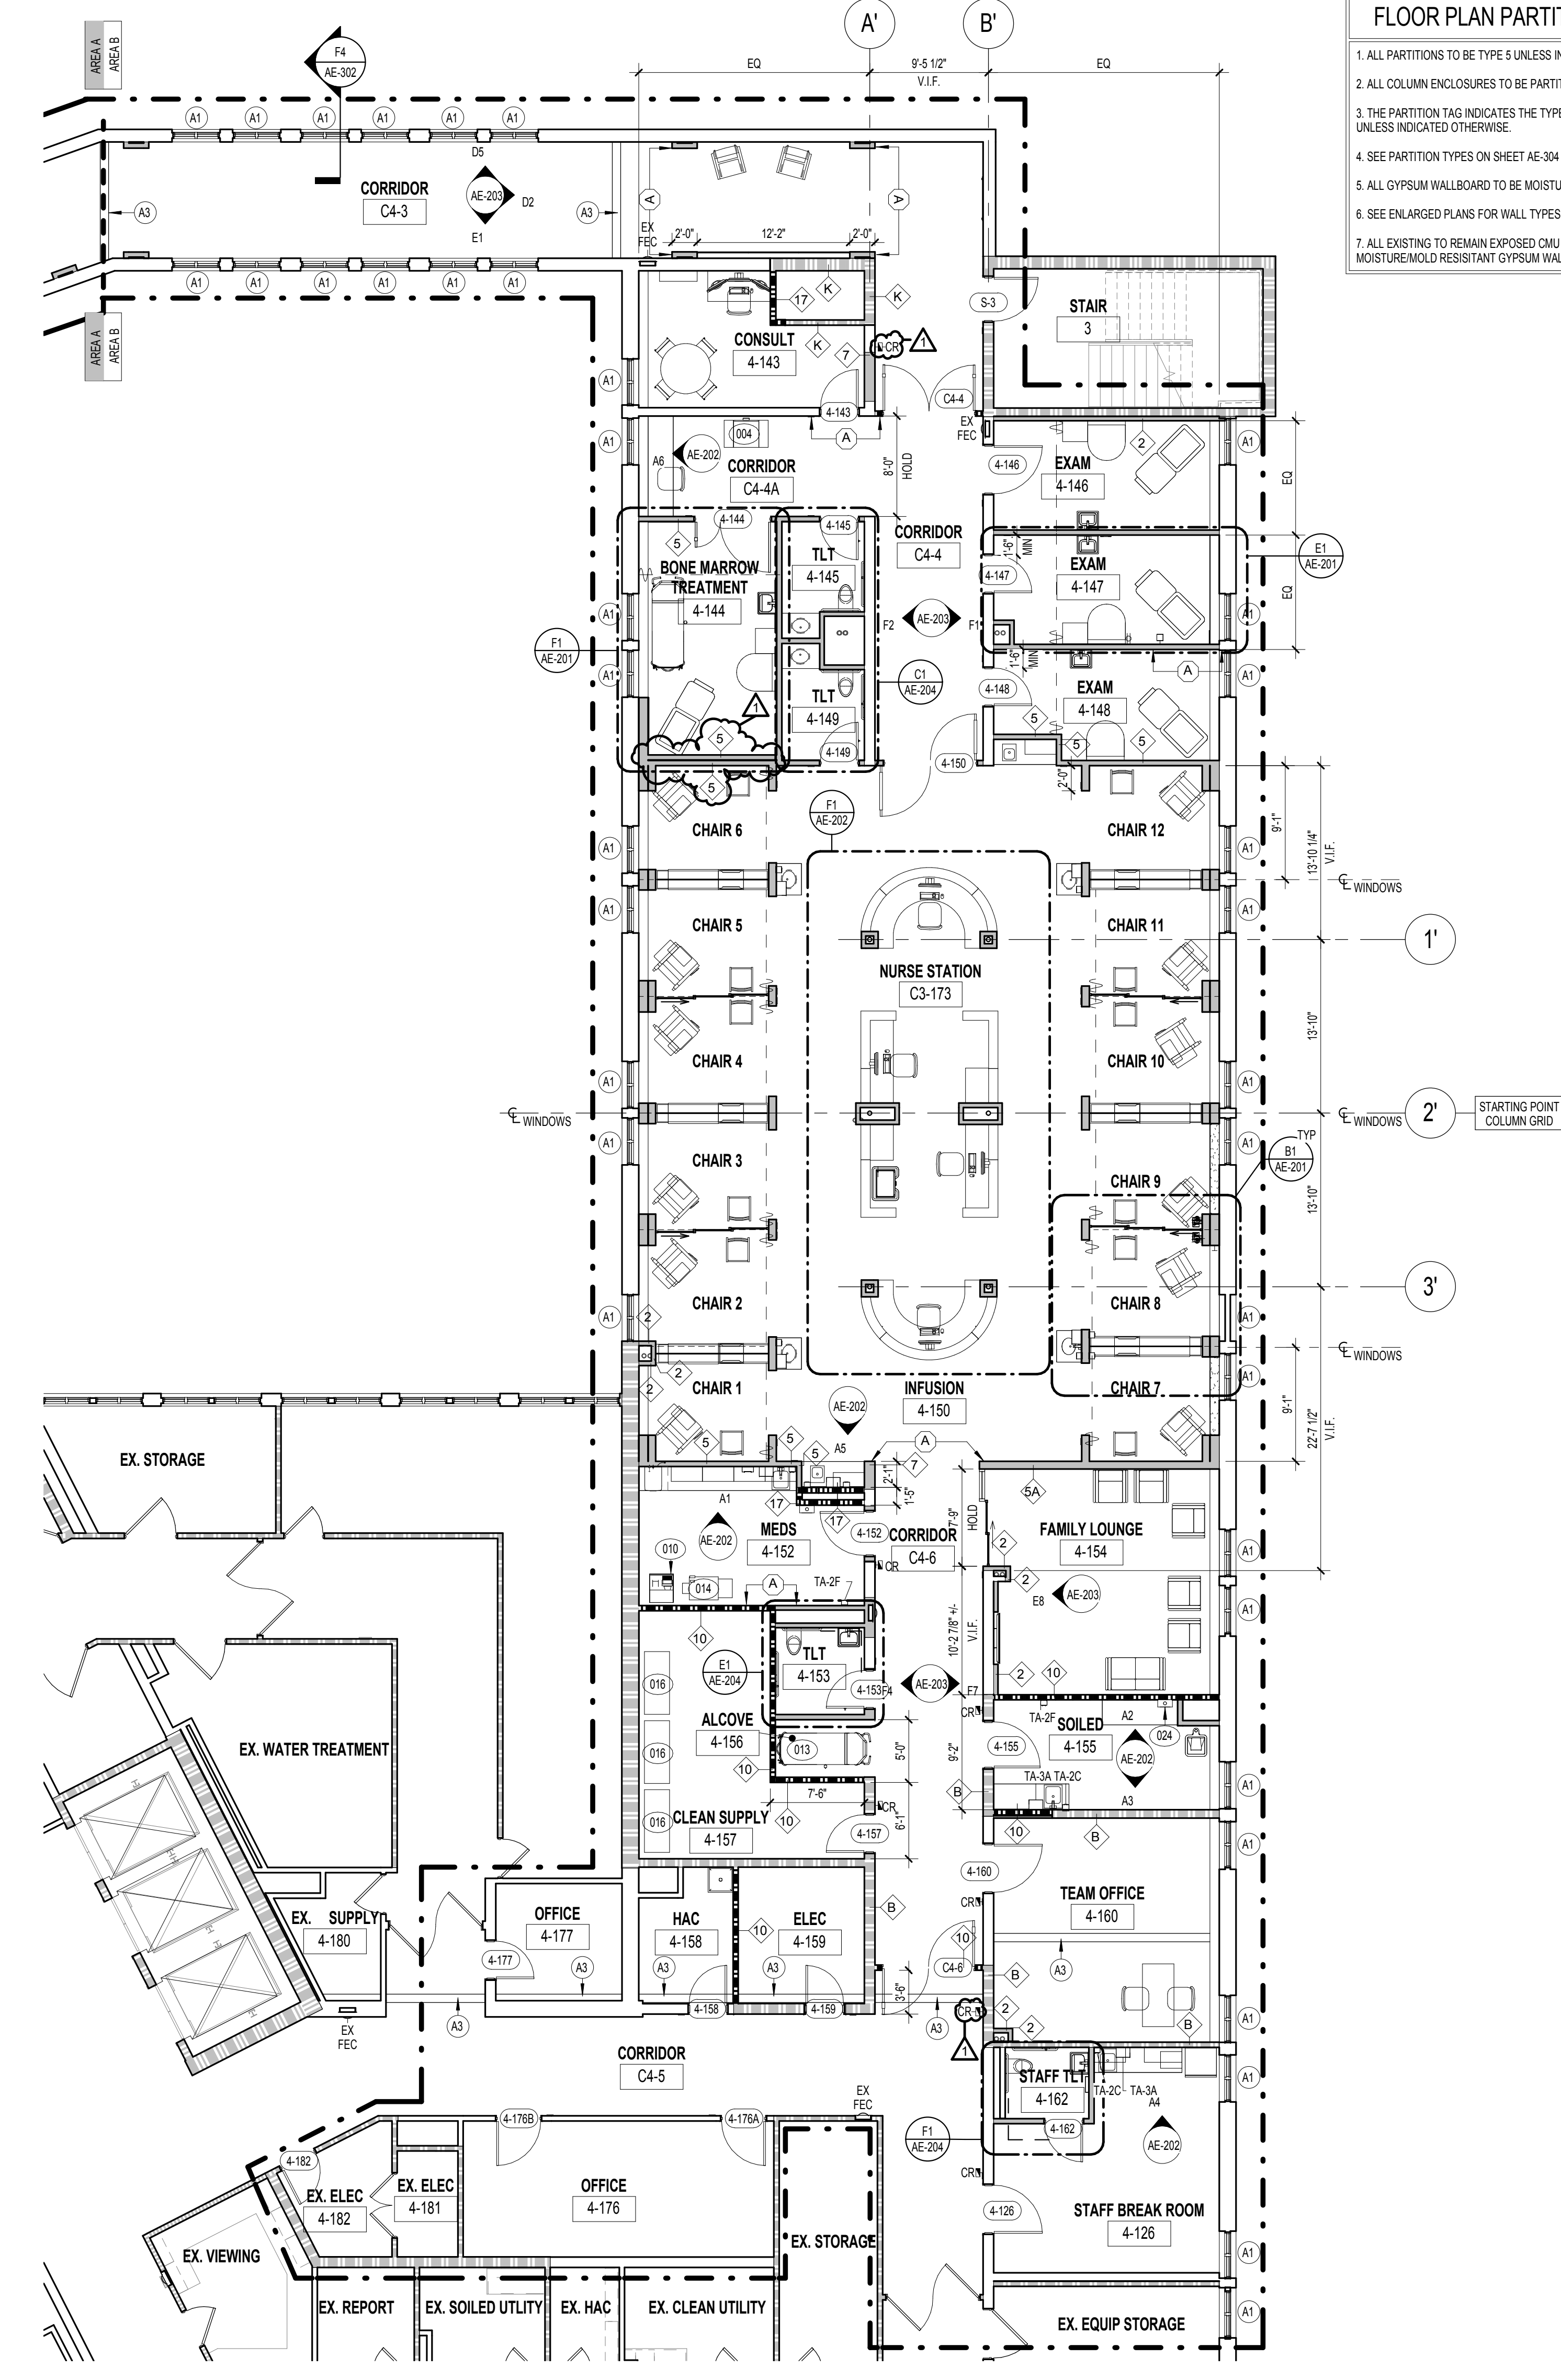


F4 FOURTH FLOOR ARCHITECTURAL PLAN AREA B  
1/8" = 1'-0"

- ### FLOOR PLAN PARTITION GENERAL NOTES
1. ALL PARTITIONS TO BE TYPE 5 UNLESS INDICATED OTHERWISE.
  2. ALL COLUMN ENCLOSURES TO BE PARTITION TYPE 2 UNLESS INDICATED OTHERWISE.
  3. THE PARTITION TAG INDICATES THE TYPE OF PARTITION FROM CORNER TO CORNER UNLESS INDICATED OTHERWISE.
  4. SEE PARTITION TYPES ON SHEET AE-304 FOR ADDITIONAL INFORMATION.
  5. ALL GYPSUM WALLBOARD TO BE MOISTURE RESISTANT PER SPECIFICATION.
  6. SEE ENLARGED PLANS FOR WALL TYPES OF ENLARGED AREAS.
  7. ALL EXISTING TO REMAIN EXPOSED CMU WALLS TO HAVE ONE LAYER OF 5/8" MOISTURE/MOLD RESISTANT GYPSUM WALLBOARD APPLIED TO WALL.

- ### ARCHITECTURAL KEYNOTES
- |    |   |
|----|---|
| A1 | INSTALL NEW ALUMINUM WINDOW IN EXISTING OPENING. VERIFY OPENING SIZE IN FIELD. SEE DETAILS ON SHEET AE-305. |
| A2 | INSTALL NEW ALUMINUM LOUVER IN EXISTING OPENING. VERIFY OPENING SIZE IN FIELD. SEE DETAILS ON SHEET AE-151. |
| A3 | INSTALL NEW EXPANSION JOINT COVER.  |
| A4 | GLASS PANEL WALL SYSTEM.  |

- ### ARCHITECTURAL FLOOR PLAN GENERAL NOTES
1. DO NOT SCALE DRAWINGS. DIMENSIONS IN LARGE SCALE PLANS, ELEVATIONS, AND DETAILS SHALL GOVERN OVER SMALL SCALE DETAILS. IF DIMENSIONS ARE IN QUESTION, THE CONTRACTOR SHALL BE RESPONSIBLE FOR OBTAINING CLARIFICATION FROM THE ARCHITECT BEFORE CONTINUING WITH CONSTRUCTION.
  2. SEE TYPICAL COLUMN ENCLOSURE DETAIL ON SHEET AE-302.
  3. WHERE A ONE HOUR OR NON-RATED PARTITION IS SHOWN AS A CONTINUATION OF A TWO HOUR PARTITION OR COLUMN ENCLOSURE, THE FACE OF THE GYPSUM BOARD SHALL BE ALIGNED. STUDS SHALL BE OFFSET AND AN ADDITIONAL LAYER OF GYPSUM BOARD SHALL BE PROVIDED TO PROVIDE FACE ALIGNMENT OF GYPSUM BOARD.
  4. ALL WALL MOUNTED LAVATORIES SHALL BE MOUNTED TO ALLOW FOR 1'-3" MINIMUM BETWEEN THE CENTERLINE OF THE LAVATORY AND FACE OF ADJACENT WALL, UNLESS OTHERWISE NOTED. THERE IS AN ADDITIONAL REQUIREMENT TO PROVIDE A MINIMUM OF 4" BETWEEN SIDE OF LAVATORY AND FACE OF ADJACENT WALL. FIXED EQUIPMENT, CASEWORK, ETC. ALL BACK-TO-BACK LAVATORIES TO BE INSTALLED IN WALL TYPE 5A.
  5. ALL WATER CLOSETS SHALL BE MOUNTED SO THAT THERE IS 1'-6" BETWEEN FACE OF THE CLOSET ADJACENT SIDE WALL OR TOILET PARTITION AND THE CENTERLINE OF THE WATER CLOSET. THE FLUSH VALVE FOR ALL WATER CLOSETS SHALL BE MOUNTED ON THE "OPEN MOST" SIDE OF THE WATER CLOSET AT 4" MAXIMUM A.F.F. TO THE TOP.
  6. CONTRACTOR SHALL BUILD OUT PARTITIONS TO ACCOMMODATE DEPTH REQUIRED BY PLUMBING WIRES.
  7. DIMENSIONS SHALL BE FIELD VERIFIED PRIOR TO FABRICATION AND INSTALLATION OF CASEWORK. REFER TO CASEWORK NOTES FOR ADDITIONAL INFORMATION.
  8. GENERAL CONTRACTOR SHALL BE RESPONSIBLE FOR LATEXING AND TAPERING EXISTING CONCRETE FLOOR SLAB WHERE MATERIAL CHANGES OCCUR.
  9. CONTRACTOR SHALL BUILD OUT PARTITIONS TO ACCOMMODATE DEPTH REQUIRED BY FIRE EXTINGUISHER CABINETS AND RECESSED POWER PANELS. COORDINATE WITH ENGINEERING DRAWINGS. FINAL LOCATIONS OF ALL CABINETS AND PANELS TO BE APPROVED BY ARCHITECT.
  10. PROVIDE METAL STUD FRAMING AROUND ALL PENETRATIONS THRU METAL STUD / GYPSUM PARTITIONS. REFER TO DETAILS TO FOLLOW FOR PATCHING PENETRATIONS IN RATED WALLS.
  11. CONTRACTOR TO COORDINATE LOCATION OF CONSTRUCTION JOINTS WITH FINISH FLOOR MATERIALS SO THAT NO CONSTRUCTION JOINT IS LOCATED BENEATH CERAMIC, PORCELAIN OR QUARRY TILES.
  12. SEE AE-201 FOR EQUIPMENT SCHEDULE.

- ### PARTITION PLAN INDICATIONS
- |     |                                   |
|-----|-----------------------------------|
| --- | EXISTING PARTITION TO BE REMOVED  |
| --- | EXISTING PARTITION TO REMAIN      |
| --- | EXISTING SMOKE PARTITION          |
| --- | EXISTING ONE HOUR SMOKE BARRIER   |
| --- | EXISTING TWO HOUR FIRE BARRIER    |
| --- | TEMPORARY PARTITION               |
| --- | TYPICAL FURRING                   |
| --- | TYPICAL NON RATED PARTITION       |
| --- | TYPICAL NON RATED SMOKE PARTITION |
| --- | TYPICAL ONE HOUR RATED PARTITION  |
| --- | TYPICAL ONE HOUR SMOKE BARRIER    |

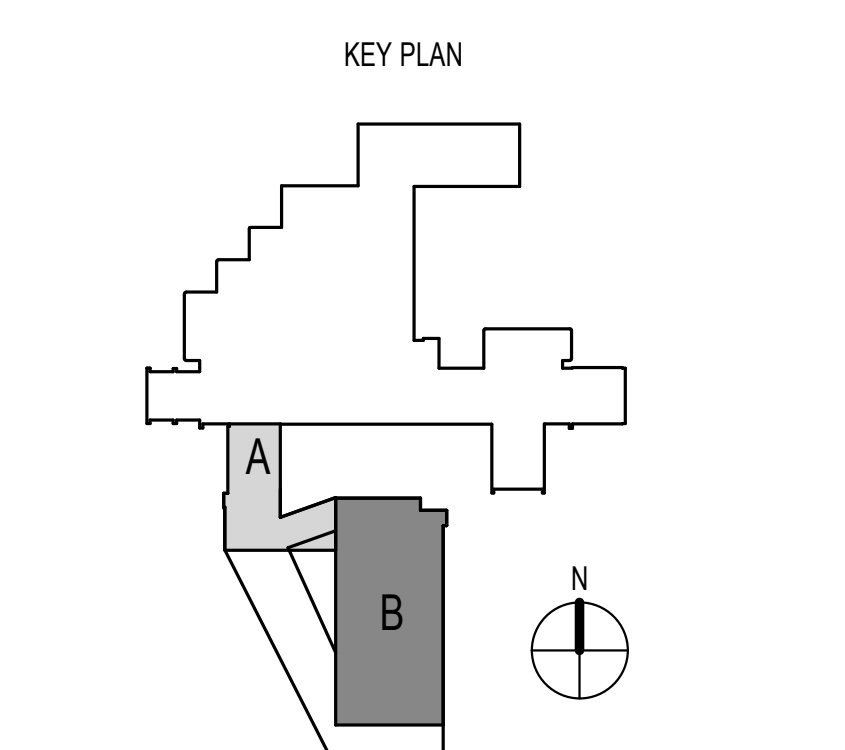

FULLY SPRINKLERED  
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<b>CONSULTANTS:</b>				<b>PROJECT MANAGER:</b>		Project Number 3659	Scale As indicated	Drawing Title FOURTH FLOOR ARCHITECTURAL & DIMENSION PLANS	Project Title EXPAND EXISTING ONCOLOGY	VA Project Number 693-11-122	Office of Facilities Management 
<b>Revisions</b>				<b>Bray Mooney Consulting</b>		410 East 21st Street Chester, PA 19013 Tel (215) 518-0864 Fax (484) 428-1547		Approved: Project Director	Location 1111 EAST END BLVD, WILKES-BARRE, PA 18711	Building Number 1 & 27	
ADDENDUM 1 08-01-13				Date 04/17/2013		Checked WJ		Drawn EN		Drawing Number AE-141	
Date				Dwg. 14		of 79					